

DATE OF AERIAL PHOTOGRAPHY  
NOVEMBER 08, 2007  
GEODIGITAL INTERNATIONAL

STEEL DE A-FRAME  
STA=0+00.00  
1 TAKEOFF STR.


ST-125  
STA=6+30.00  
2

SD90-095  
STA=346+67.52  
3 AP 1

ST-125  
STA=354+70.00  
4

LEFT PROFILE 20'  
RIGHT PROFILE 20'

200.0 FT. HORIZ. SCALE  
20.0 FT. VERT. SCALE

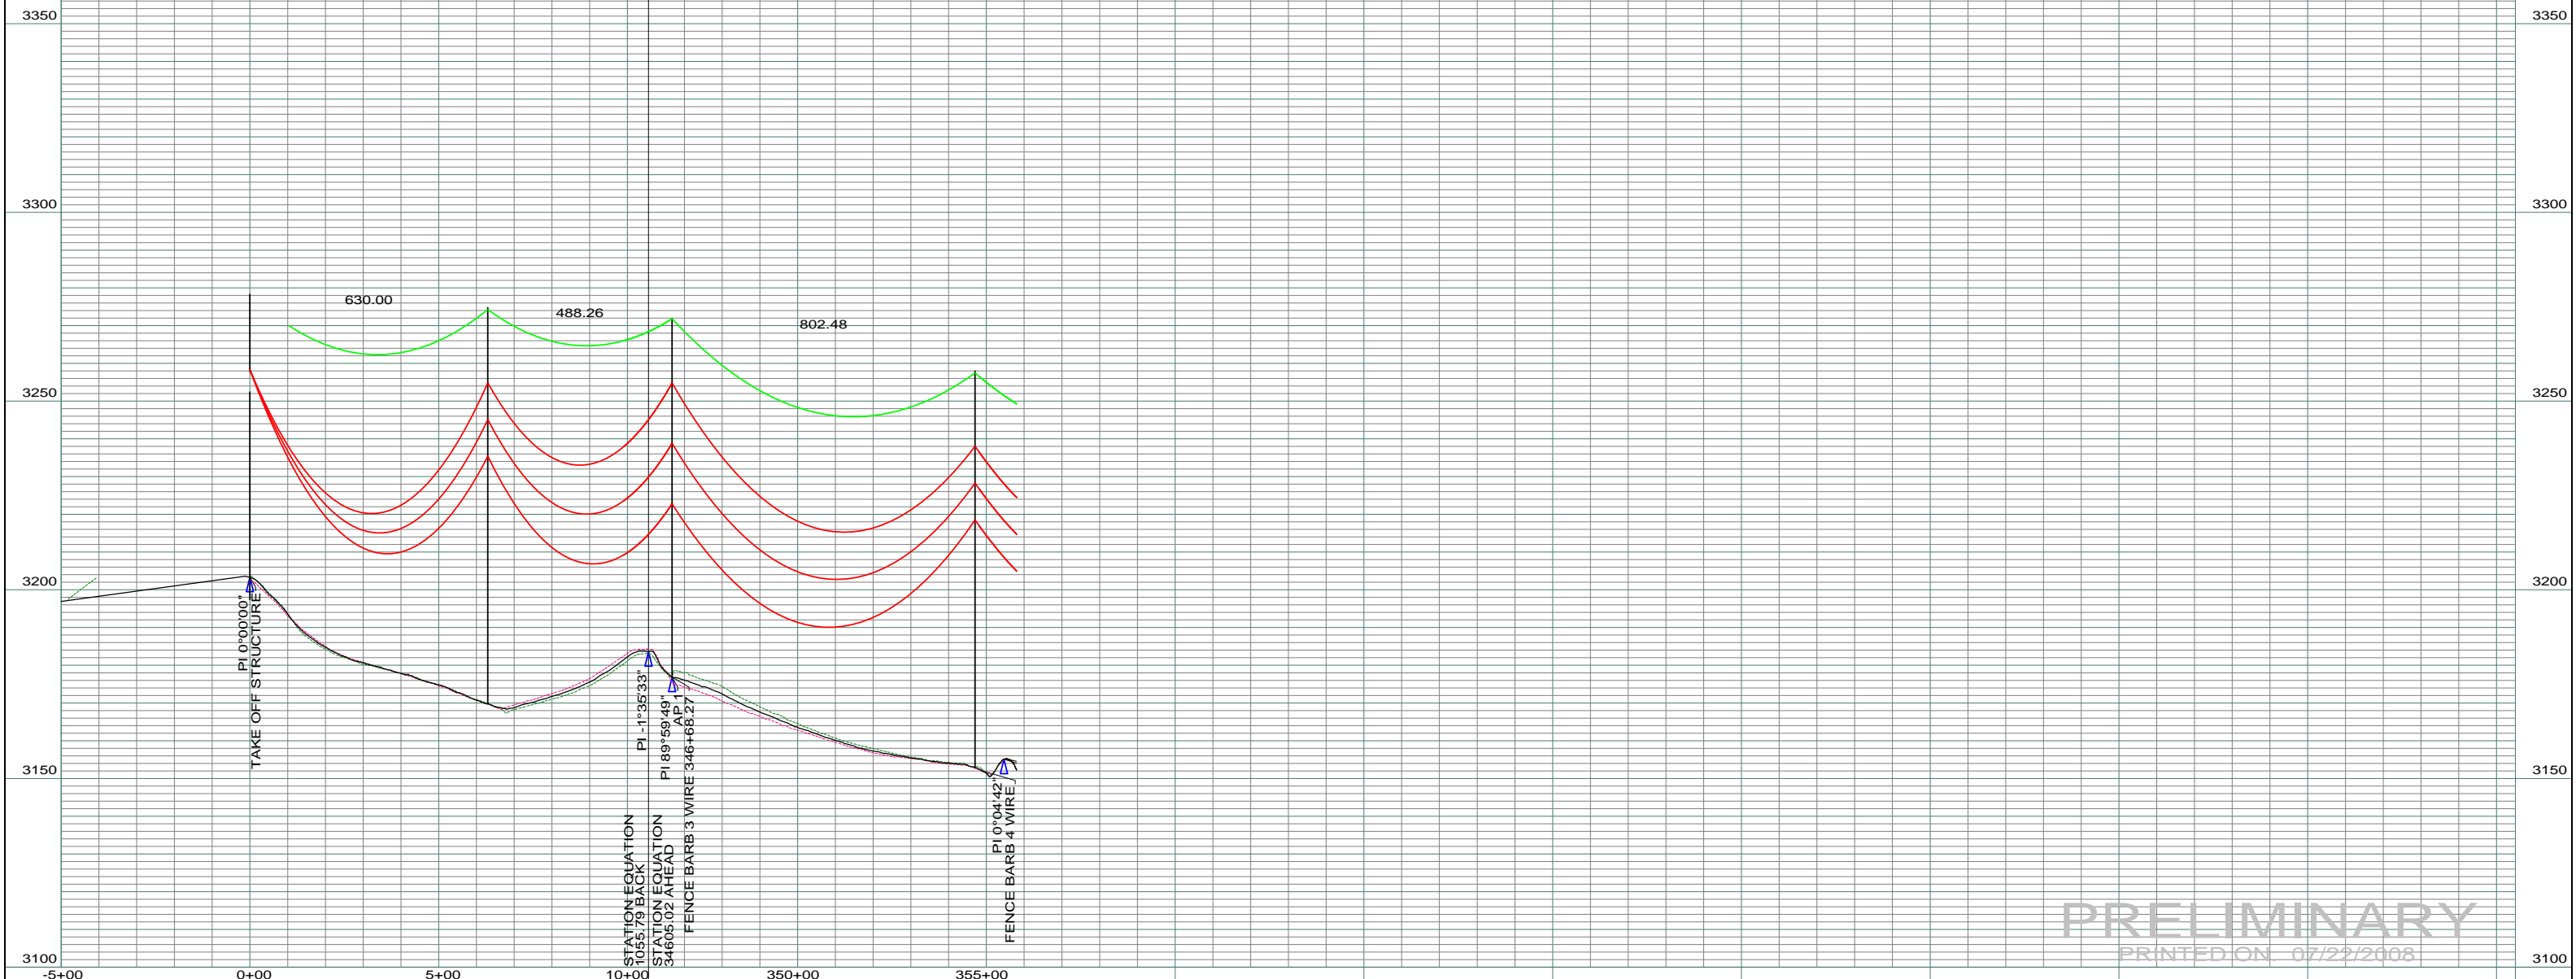

**PRELIMINARY**  
PRINTED ON 07/22/2008

REV	DESCRIPTION	DRWN	DSGN	APPD	DATE	REV	DESCRIPTION	DRWN	DSGN	APPD	DATE
1	-	-	-	-	-	5	-	-	-	-	-
2	-	-	-	-	-	-	-	-	-	-	-
3	-	-	-	-	-	-	-	-	-	-	-
4	-	-	-	-	-	-	-	-	-	-	-

STATE NAME: NORTH DAKOTA		ZONE: 3302 SOUTH		DESIGN BY:	DAM/CDB	04/03/08	FACILITY:	TRANSMISSION SYSTEM MAINTENANCE
DESIGN INFORMATION		DRAWN BY:		CDB	07/22/2008	LOCATION UNIT:		181 - RHAME SUB TO BELFIELD SUB - 230 KV LINE
CONDUCTOR	1272 MCM ACSR	STRINGING TENSION	-	DESIGN RULING SPAN	-	DESIGN CHK:	-	<b>RHAME TO BELFIELD TRANSMISSION PROJECT</b> PLAN AND PROFILE MILE 1 & FROM RHAME SUBSTATION
OHGW	7/16" E.H.S. STEEL	DESIGN RULING SPAN	-	ACTUAL RULING SPAN	-	DRAFT CHK:	-	
OPGW	AC 86/596	DESIGN RULING SPAN	-	ACTUAL RULING SPAN	-	APPROVED:	-	
SCALE: AS SHOWN		COUNTY NAME: BOWMAN		BASIN DRAWING NO. 181-090-T3-001		REV. 0		BASIN ELECTRIC POWER COOPERATIVE 1717 EAST INTERSTATE AVENUE BISMARCK, NORTH DAKOTA PHONE 701-223-0441