


DATE OF AERIAL PHOTOGRAPHY
NOVEMBER 08, 2007
GEODIGITAL INTERNATIONAL

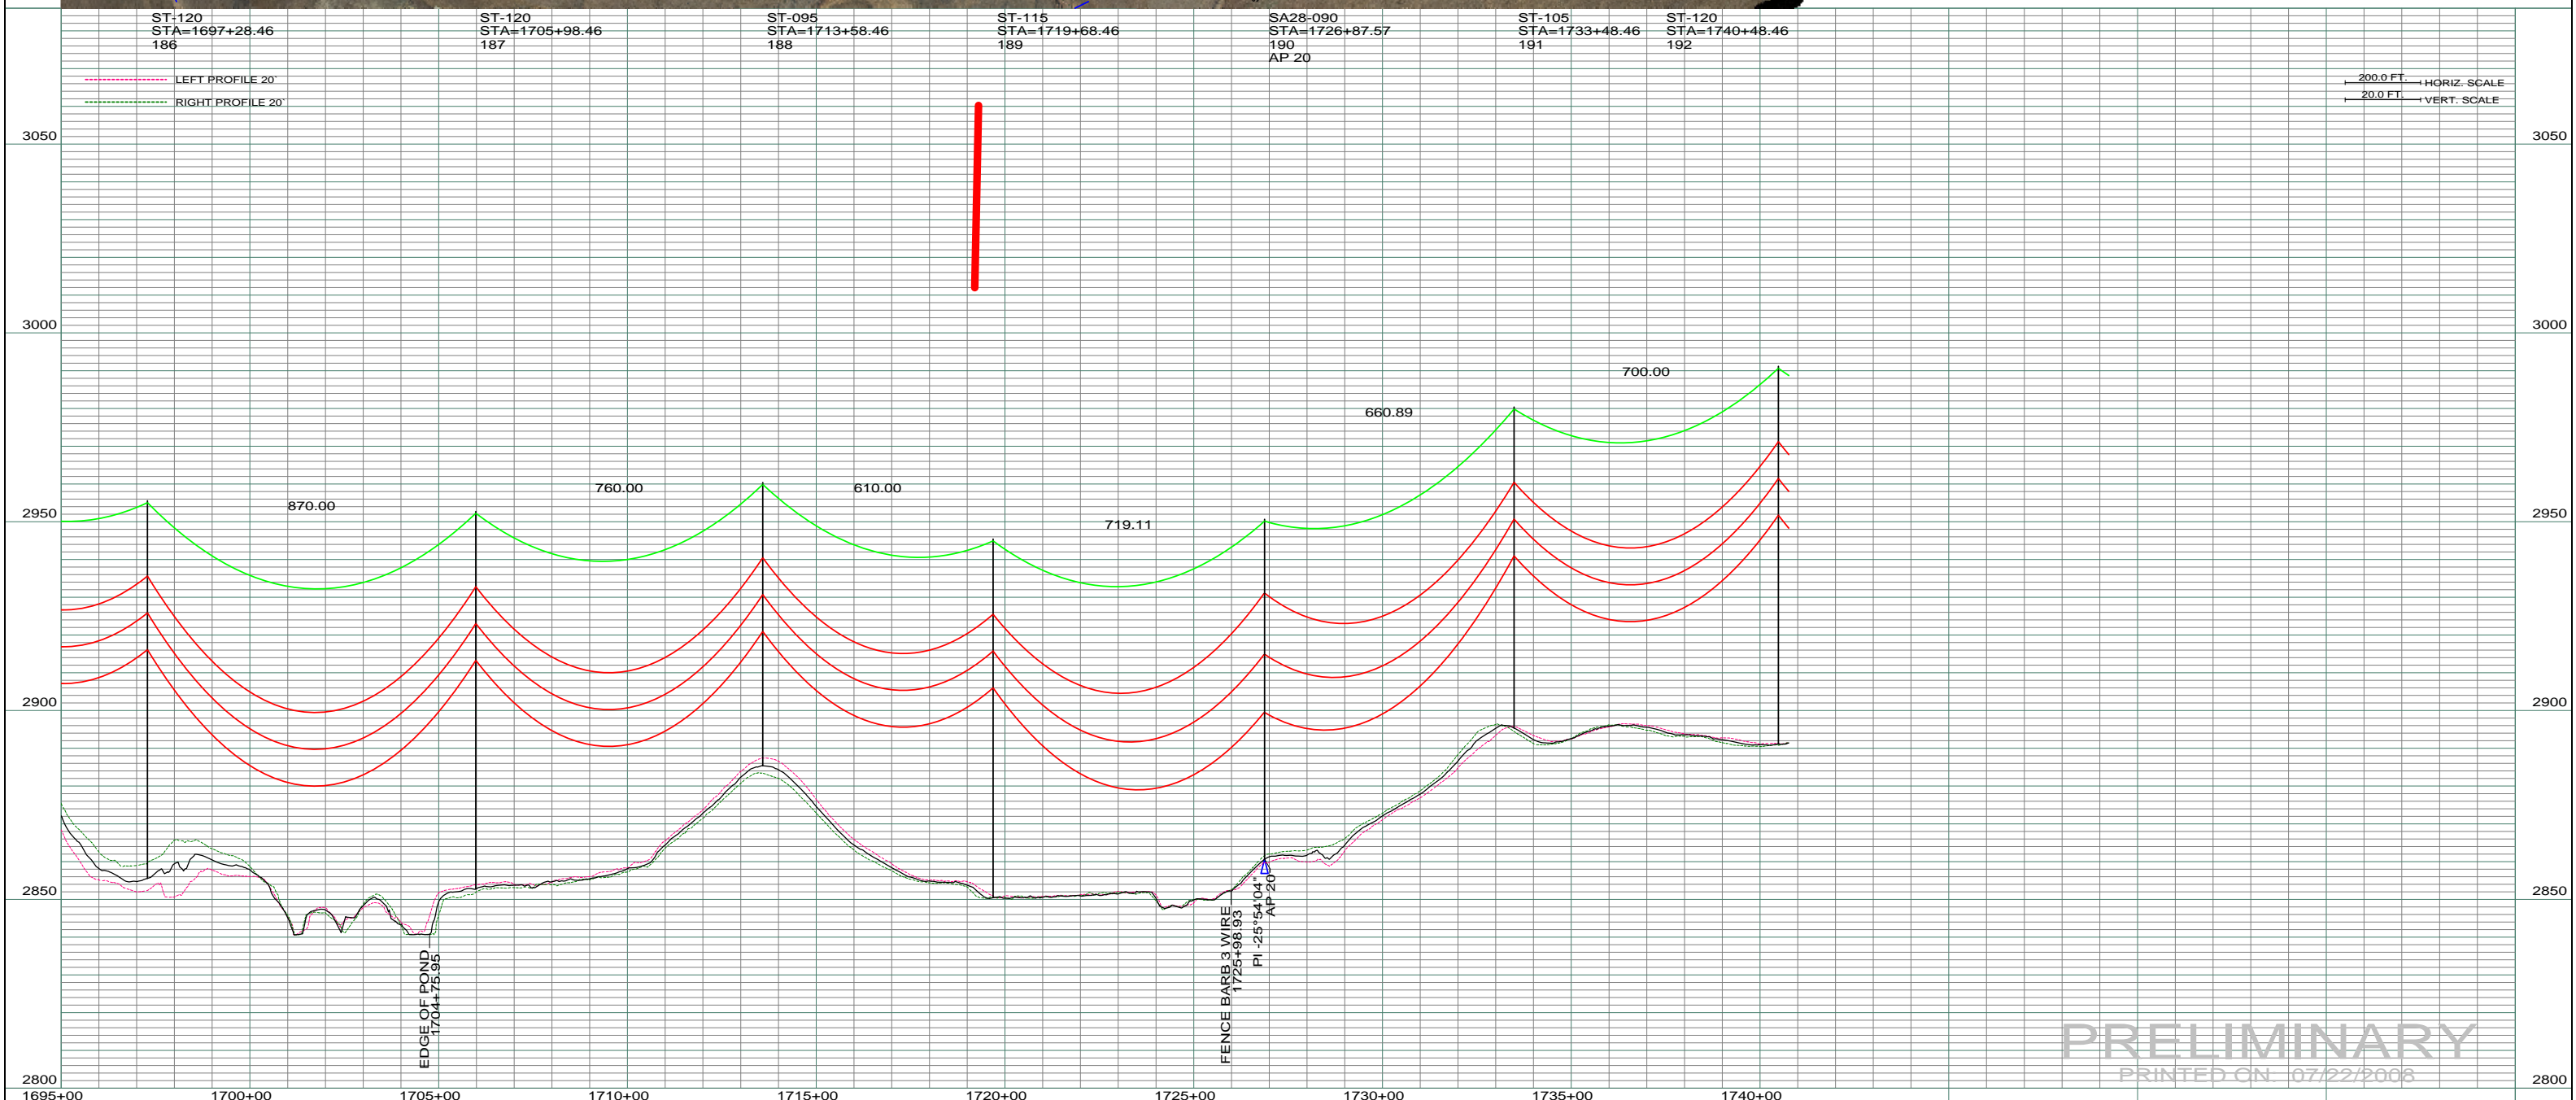

PRELIMINARY
PRINTED ON 07/22/2008

REV	DESCRIPTION	DRWN	DSGN	APPD	DATE	REV	DESCRIPTION	DRWN	DSGN	APPD	DATE	STATE NAME: NORTH DAKOTA	ZONE: 3302 SOUTH	DESIGN BY: DAM/CDB	04/03/08	FACILITY: TRANSMISSION SYSTEM MAINTENANCE	LOCATION UNIT: 181 - RHAME SUB TO BELFIELD SUB - 230 KV LINE	BASIN ELECTRIC POWER COOPERATIVE
1		-	-	-	-	5						DESIGN INFORMATION			BASIN ELECTRIC POWER COOPERATIVE			
2		-	-	-	-							CONDUCTOR	1272 MCM ACSR	STRINGING TENSION	NEST TENSION	DESIGN RULING SPAN	ACTUAL RULING SPAN	1717 EAST INTERSTATE AVENUE
3		-	-	-	-							OHGW	7/16" E.H.S. STEEL					BISMARCK, NORTH DAKOTA
4		-	-	-	-							OPGW	AC 86/596					PHONE 701-223-0441
												DESIGN CHK: -		RHHAME TO BELFIELD TRANSMISSION PROJECT		SCALE: AS SHOWN	COUNTY NAME: SLOPE	
												DRAFT CHK:		PLAN AND PROFILE		BASIN DRAWING NO. 181-90-T3-030	REV. 0	
												APPROVED:						