


0590
 NEAL FREITAG, ETAL
 NE 1/4 SEC. 2-T133N-R100W
 CENTERLINE LENGTH 2921.44'-177.06 RODS-8.38 ACRES
 STA 2025+55.07 TO STA 2053+80.53 BACK
 STA 2054+19.54 AHEAD TO STA 2055+15.02

DATE OF AERIAL PHOTOGRAPHY
 NOVEMBER 08, 2007
 GEODIGITAL INTERNATIONAL

ST-115 STA=2020+03.21 228	ST-095 STA=2026+03.21 229	ST-115 STA=2034+53.21 230	ST-110 STA=2042+03.21 231	ST-110 STA=2049+03.21 232	ST-115 STA=2056+23.21 233	ST-105 STA=2063+83.21 234	SD65-100 STA=2071+81.79 235 AP 24	ST-110 STA=2079+73.21 236
---------------------------------	---------------------------------	---------------------------------	---------------------------------	---------------------------------	---------------------------------	---------------------------------	--	---------------------------------

LEFT PROFILE 20'
 RIGHT PROFILE 20'

200.0 FT. HORIZ. SCALE
 20.0 FT. VERT. SCALE

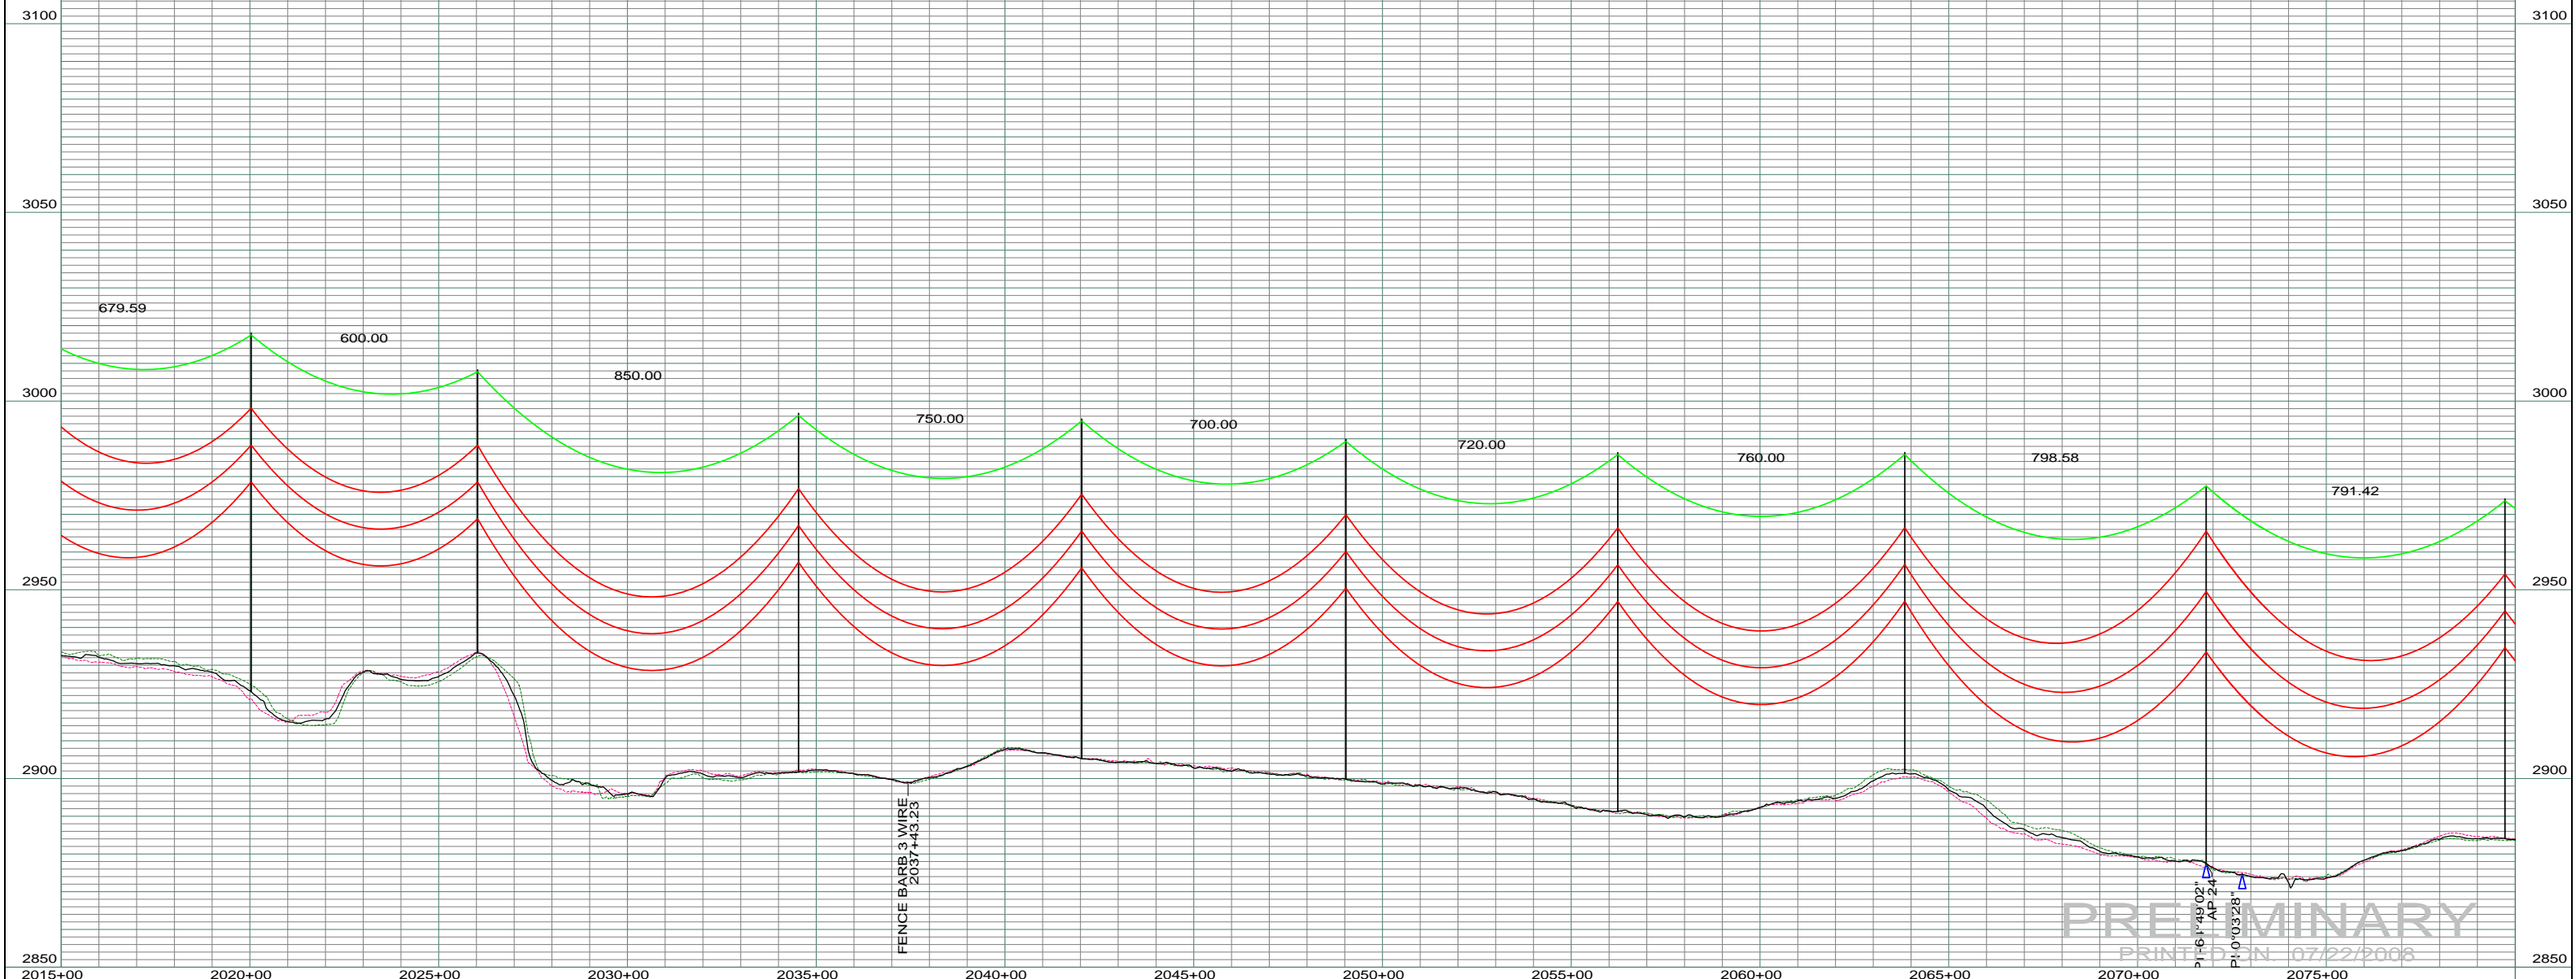

REV	DESCRIPTION	DRWN	DSGN	APPD	DATE	REV	DESCRIPTION	DRWN	DSGN	APPD	DATE
1		-	-	-	-	5					
2		-	-	-	-						
3		-	-	-	-						
4		-	-	-	-						

STATE NAME:	ZONE:	DESIGN BY:	DATE:	FACILITY:
NORTH DAKOTA	3302 SOUTH	DAM/CDB	04/03/08	TRANSMISSION SYSTEM MAINTENANCE
DESIGN INFORMATION		DRAWN BY:	DATE:	LOCATION UNIT:
CONDUCTOR	SIZE	STRINGING TENSION	NESC TENSION	DESIGN RULING SPAN
	1272 MCM ACSR			
	7/16" E.H.S. STEEL			
	AC 86/596			

DESIGN BY:	DATE:	FACILITY:	LOCATION UNIT:
DAM/CDB	04/03/08	TRANSMISSION SYSTEM MAINTENANCE	181 - RHAME SUB TO BELFIELD SUB - 230 KV LINE
DRAWN BY:	DATE:	RHAME TO BELFIELD TRANSMISSION PROJECT	
CDB	07/22/2008	PLAN AND PROFILE	
DESIGN CHK:		SCALE: AS SHOWN	
DRAFT CHK:		COUNTY NAME: SLOPE	
APPROVED:		BASIN DRAWING NO. 181-90-T3-037	

SCALE:	COUNTY NAME:	REV.
AS SHOWN	SLOPE	0
BASIN DRAWING NO. 181-90-T3-037		