


0650
 WILBUR & MARY PARKIN TRUST
 E1/2 SEC. 13-T134N-R100W
 CENTERLINE LENGTH 5460.03'-
 330.91 RODS- 15.67 ACRES
 STA 2227+01.83 TO STA 2281+60.93

DATE OF AERIAL PHOTOGRAPHY
 NOVEMBER 08, 2007
 GEODIGITAL INTERNATIONAL

ST-125 STA=2236+43.21 255	SA23-100 STA=2246+10.67 256 AP 26	ST-105 STA=2252+66.15 257	ST-115 STA=2259+76.15 258	ST-115 STA=2267+86.15 259	ST-110 STA=2275+46.15 260	ST-115 STA=2283+06.15 261	ST-105 STA=2291+46.15 262	SA16-085 STA=2295+26.20 263 AP 27
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--- LEFT PROFILE 20'
 --- RIGHT PROFILE 20'

200.0 FT. --- HORIZ. SCALE
 20.0 FT. --- VERT. SCALE

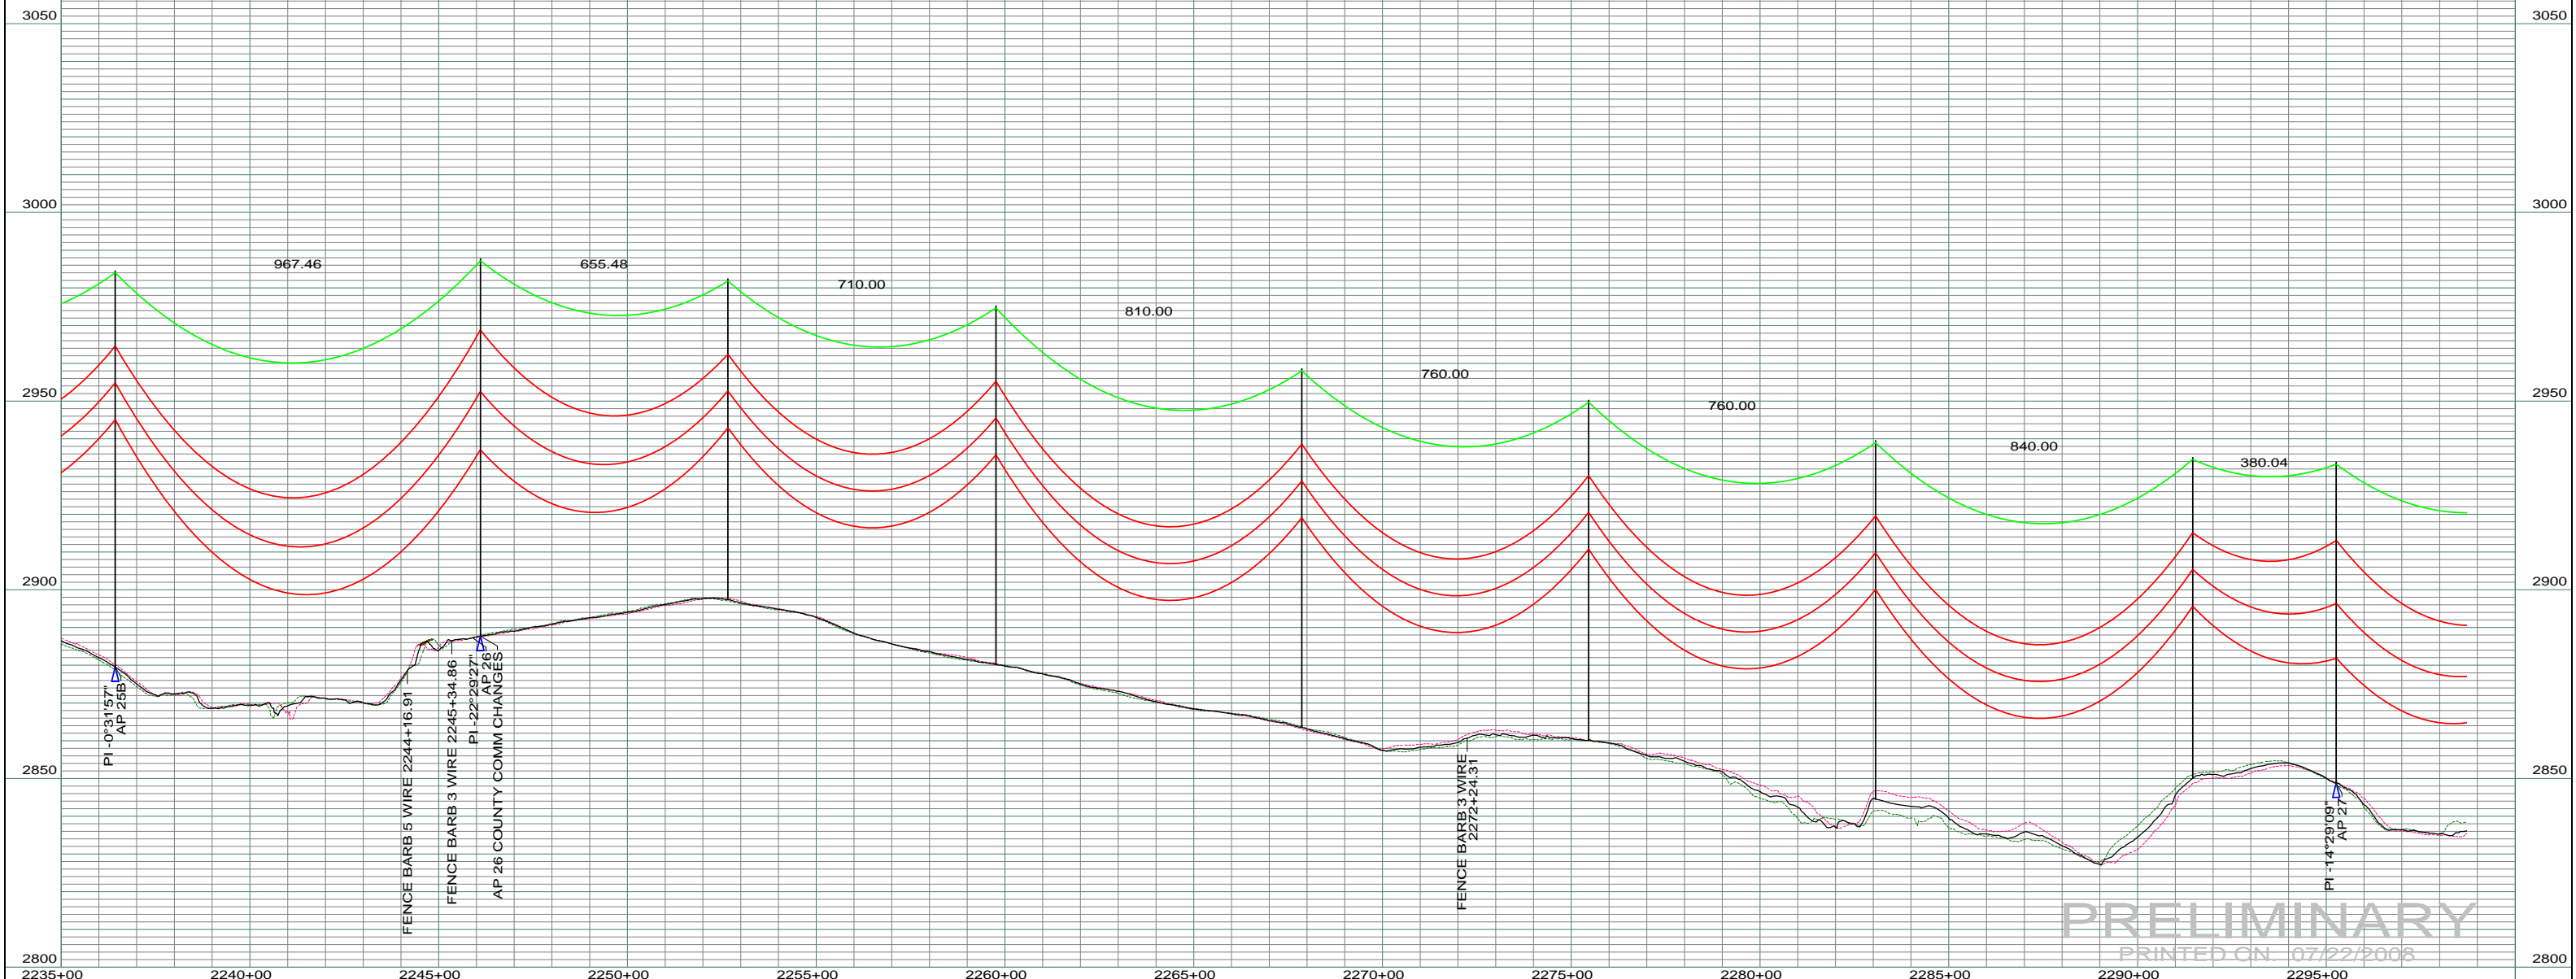

PRELIMINARY
 PRINTED ON 07/22/2008

REV	DESCRIPTION	DRWN	DSGN	APPD	DATE	REV	DESCRIPTION	DRWN	DSGN	APPD	DATE
1		-	-	-	-	5					
2		-	-	-	-						
3		-	-	-	-						
4		-	-	-	-						

STATE NAME: NORTH DAKOTA		ZONE: 3302 SOUTH		DESIGN BY: DAM/CDB	04/03/08	FACILITY: TRANSMISSION SYSTEM MAINTENANCE
DESIGN INFORMATION				DRAWN BY: CDB	07/22/2008	LOCATION UNIT: 181 - RHAME SUB TO BELFIELD SUB - 230 KV LINE
CONDUCTOR	1272 MCM ACSR	STRINGING TENSION	NESC TENSION	DESIGN RULING SPAN	ACTUAL RULING SPAN	RHAME TO BELFIELD TRANSMISSION PROJECT PLAN AND PROFILE
OHGW	7/16" E.H.S. STEEL					
OPGW	AC 86/596					
				DESIGN CHK: -		
				DRAFT CHK:		
				APPROVED:		

SCALE: AS SHOWN	COUNTY NAME: SLOPE
BASIN DRAWING NO. 181-90-T3-041	REV. 0