

ST-120  
STA=3408+80.00  
461

ST-110  
STA=3415+50.00  
462

SD48-095  
STA=3422+78.04  
463  
AP 48


ST-105  
STA=3429+10.00  
464

LEFT PROFILE 20'

RIGHT PROFILE 20'

200.0 FT. HORIZ. SCALE

20.0 FT. VERT. SCALE

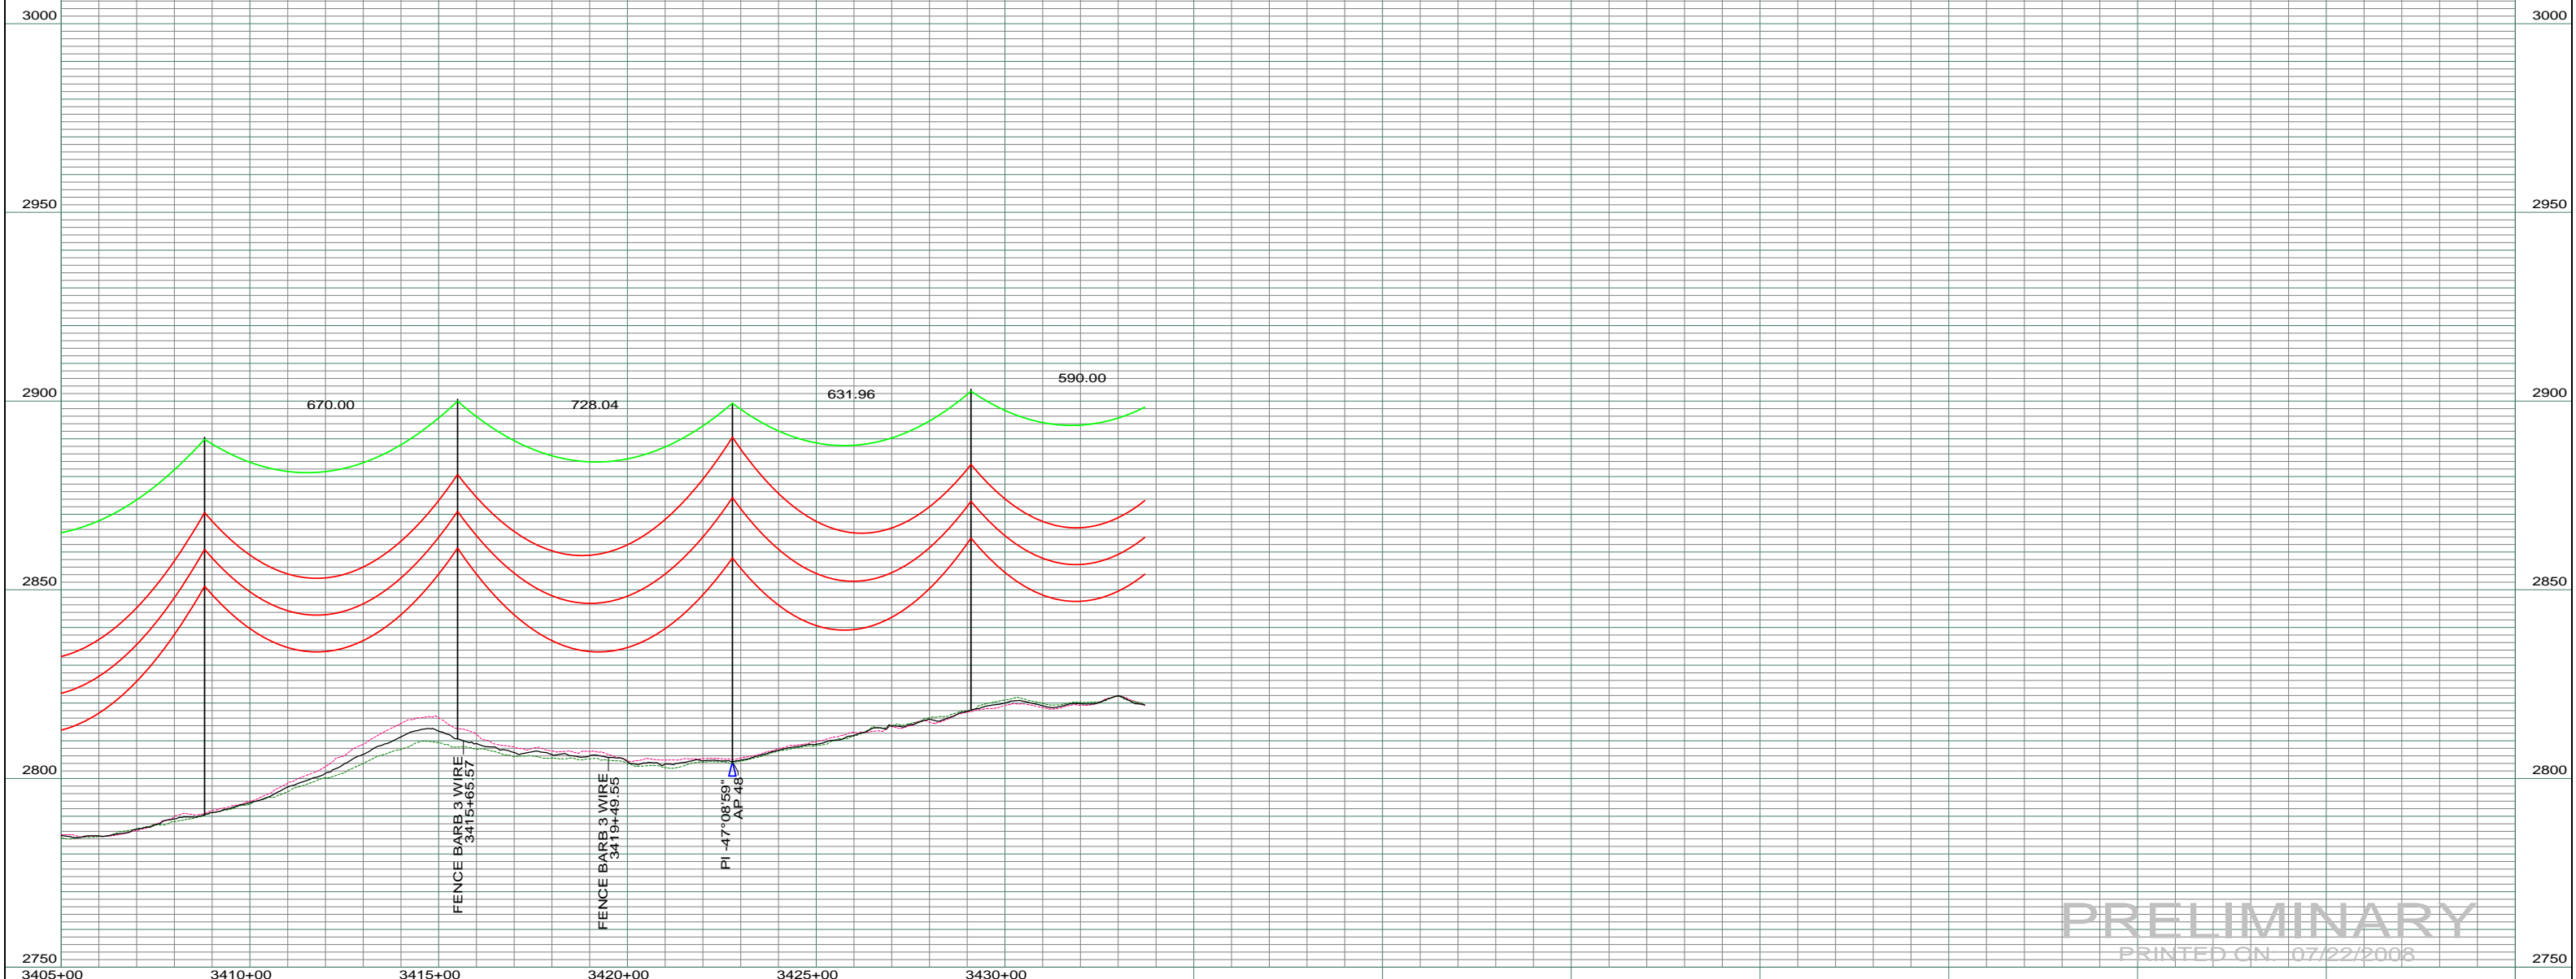

REV	DESCRIPTION	DRWN	DSGN	APPD	DATE	REV	DESCRIPTION	DRWN	DSGN	APPD	DATE
1	-	-	-	-	-	5					
2	-	-	-	-	-						
3	-	-	-	-	-						
4	-	-	-	-	-						

DESIGN INFORMATION		DESIGN BY:	DATE
CONDUCTOR	1272 MCM ACSR	DAM	07/22/2008
OHGW	7/16" E.H.S. STEEL	DRAWN BY:	CDB
OPGW	AC 86/596	DESIGN CHK:	-
		DRAFT CHK:	
		APPROVED:	

STATE NAME:	NORTH DAKOTA	ZONE:	3302 SOUTH
FACILITY:	TRANSMISSION SYSTEM MAINTENANCE		
LOCATION UNIT:	181 - RHAME SUB TO BELFIELD SUB - 230 KV LINE		
RHAME TO BELFIELD TRANSMISSION PROJECT			
PLAN AND PROFILE			

SCALE: AS SHOWN

BASIN DRAWING NO. 181-90-T3-068

REV. 0

COUNTY NAME: BOWMAN

BASIN ELECTRIC POWER COOPERATIVE  
1717 EAST INTERSTATE AVENUE  
BISMARCK, NORTH DAKOTA  
PHONE 701-223-0441